
TEMPE, ARIZONA 85284 PH 602.635.4226

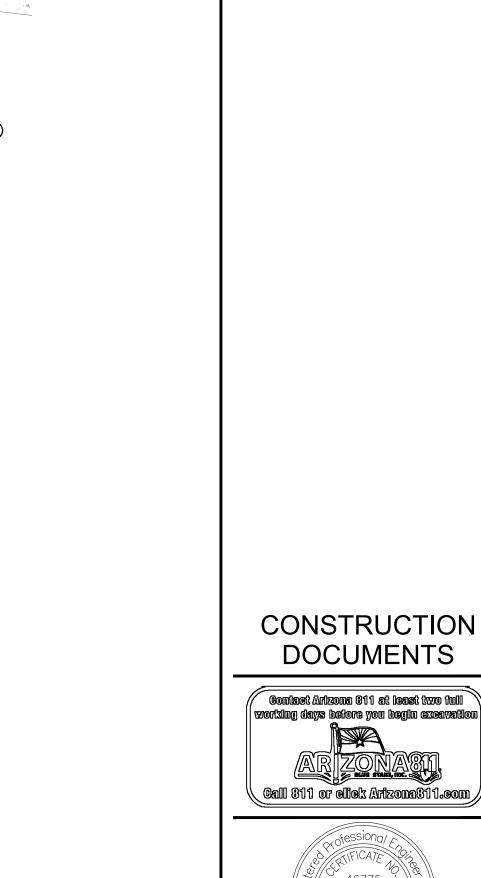


# QUEEK CREEK JH **TRANSPORTATION** CENTER ADDITION

20948 E. QUEEN CREEK ROAD QUEEN CREEK, AZ 85142

DESIGNED:	JLP
DATE:	FEB. 21, 2025
DRAWN:	JI
PROJ.	24-124
SCALE:	1" = 20'

PAVING PLAN

DWG. NO. C4-1

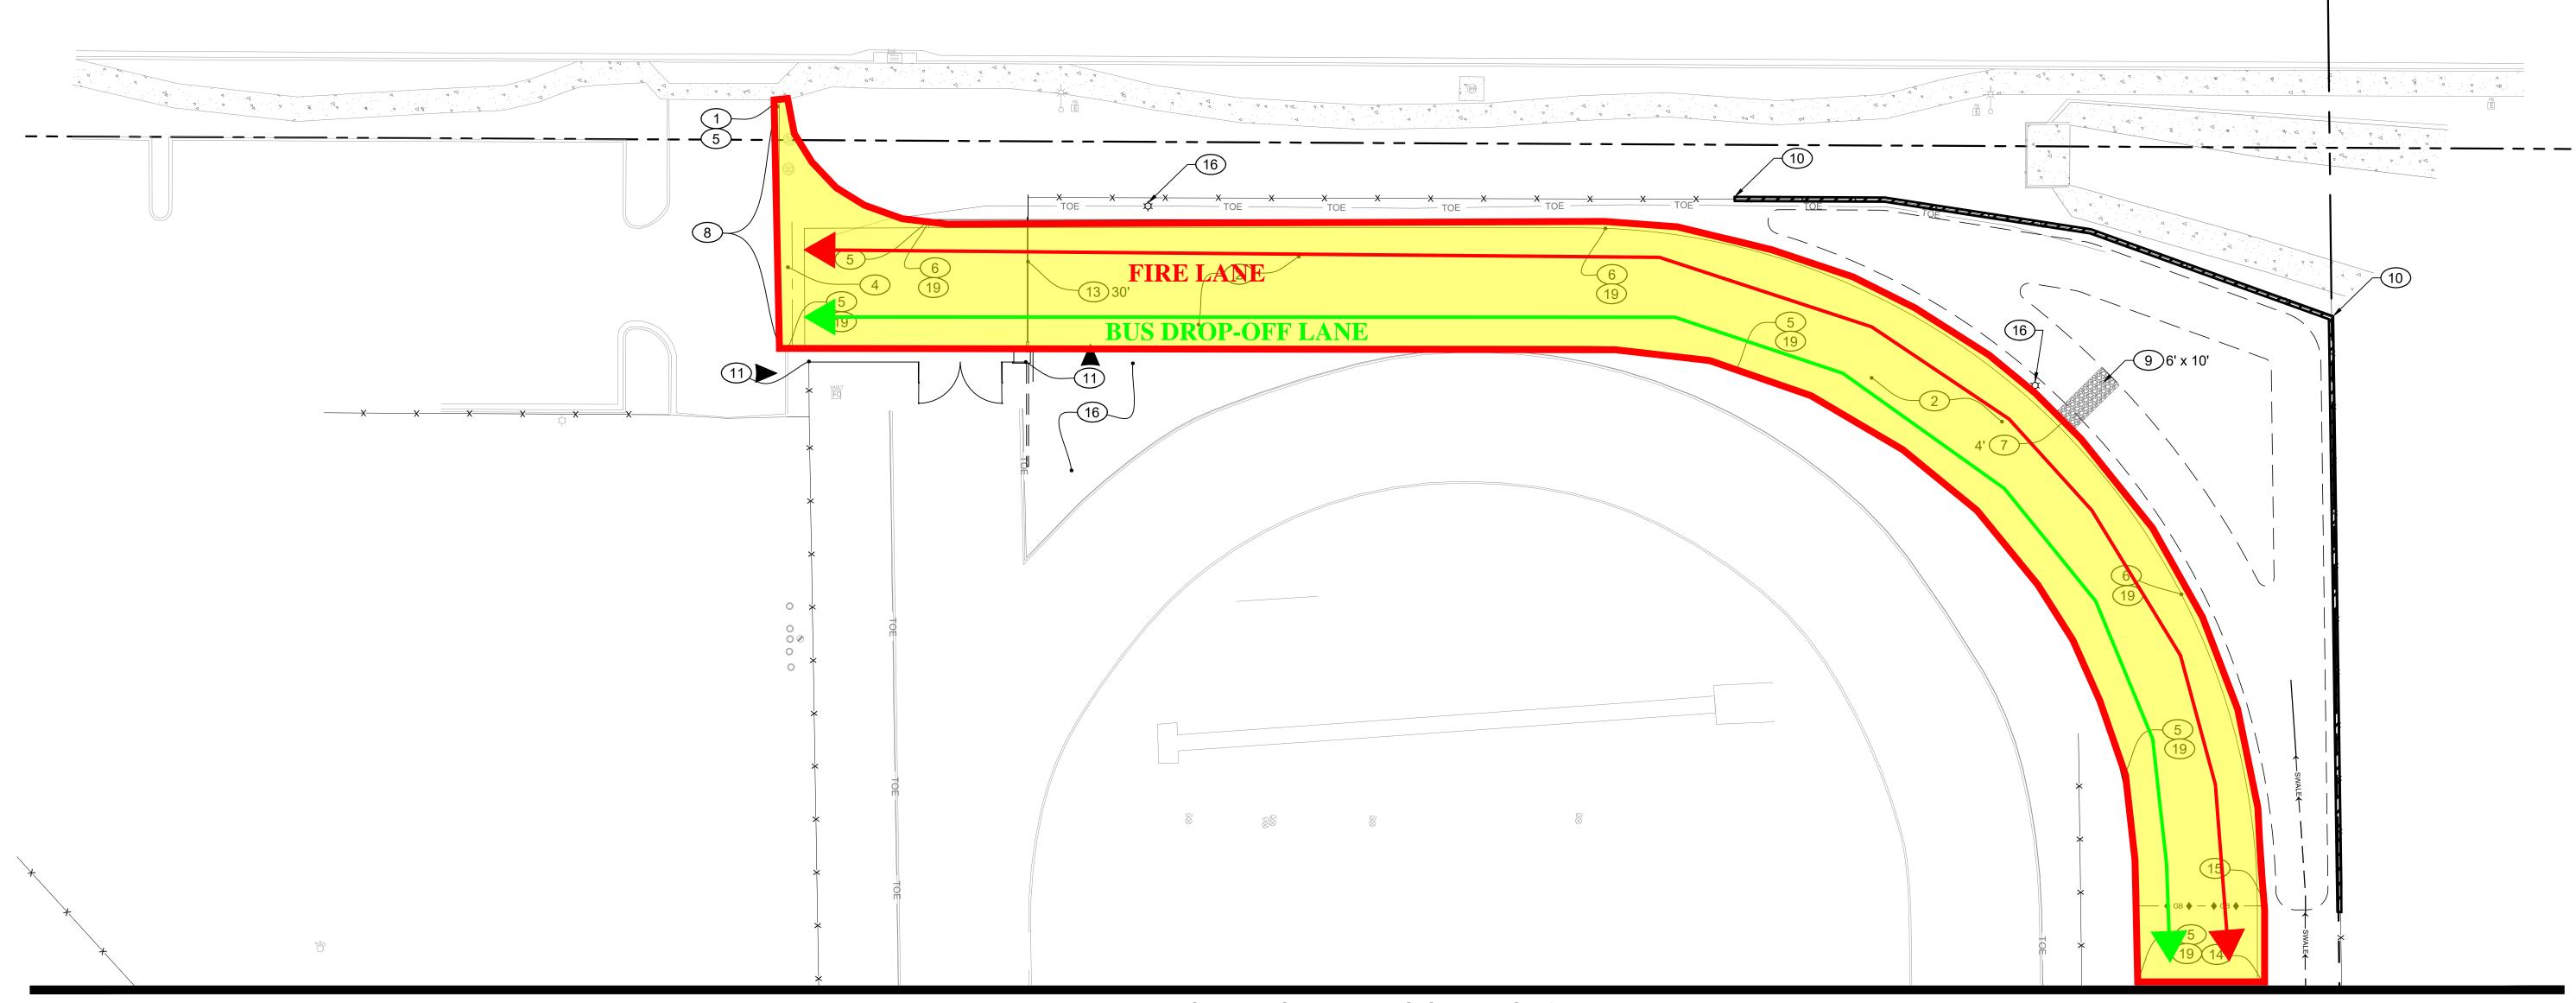

#### PAVING KEYNOTES:


- 1 CONTRACTOR TO VERIFY ELEVATION OF EXISTING CURB OR SIDEWALK TIE-IN LOCATION AND MATCH EXISTING. NOTIFY ENGINEER OF ANY DISCREPANCIES.
- 2 CONSTRUCT 3" AC OVER 8" ABC OVER 10" COMPACTED SUBGRADE PER MAG SPECIFICATION AND GEOTECHNICAL REPORT REQUIREMENTS. REFER TO DETAIL 1 ON SHEET C5-1.
- 3 CONSTRUCT 12" THICK CONCRETE PAVEMENT, CLASS "A" 3,000 PSI, ON COMPACTED SUBGRADE PER MAG SPECIFICATION AND GEOTECHNICAL REPORT REQUIREMENTS. REFER TO ARCHITECTURAL PLANS FOR FINISH AND COLOR.
- 4 CONSTRUCT 6' WIDE VALLEY GUTTER PER MAG STD. DTL. 240.
- 5 CONSTRUCT 6" SINGLE CURB PER MAG STD. DTL. 222 TYPE "A".
- 6 CONSTRUCT 6" VERTICAL CURB AND GUTTER PER MAG STD. DTL. 220-1 TYPE "A"
- 7 INSTALL CURB OPENING, PER DETAIL 2 ON SHEET C5-1, WIDTH PER
- 8 CONSTRUCT ASPHALT THICKEN EDGE PER MAG STD. DTL. 201 TYPE
- 9 INSTALL RIPRAP SPILL WAY PER DETAIL 3 ON SHEET C5-1. LENGTH AND WIDTH PER PLAN.
- (10) CONSTRUCT 2' RETAINING WALL PER ARCHITECTURAL DETAIL.
- (11) INSTALL CHAIN LINK FENCE AND GATES PER ARCHITECTURAL PLANS.
- 12 REFER TO FUELING PLANS FOR TANK, PUMPS, PIPING, AND SAFETY
- (13) INSTALL ACCESS GATE, WIDTH PER ARCHITECTURAL PLANS.

- (14) CONSTRUCT 2' RIBBON CURB PER MAG STD. DTL. 220-1 TYPE "B".
- (15) CONSTRUCT SINGLE CURB TERMINATION PER MAG STD. DTL. 222.
- SEE ARCHITECTURAL PLANS FOR HARDSCAPE IMPROVEMENT, FOR LANDSCAPE DETAILS, AND ALL SITE LIGHTING AND DETAILS. COORDINATE CONDUIT PRIOR TO CONCRETE OR PAVING.
- 17 INSTALL 4" SOLID WHITE LINE PER PAVEMENT MARKINGS DETAIL 4 ON SHEET C5-1. DIMENSION OF STRIP PER PLAN VIEW.
- NO ACCESS / NO PARKING 4" SOLID WHITE LINE SPACED 3' AT 45° ANGLE.
- 19 FIRE LANE TO BE IDENTIFIED AND MARKED WITH RED PAINTED CURBING ON VERTICAL FACE OR BACK OF RIBBON CURB WITH THREE (3) INCH WHITE LETTERING WITH A  $\frac{3}{4}$  INCH STROKE, SPACED AT A MAXIMUM OF FIFTY (50) FEET BETWEEN MARKINGS.

#### NOTES:

- ENSURE ALL IRRIGATION AND ELECTRICAL SLEEVES ARE INSTALLED PRIOR TO PAVEMENT PLACEMENT.
- 2. COORDINATE ALL SLEEVES WITH ELECTRICAL AND LANDSCAPE

# MATCHLINE SEE PAVING SHEET C4-2

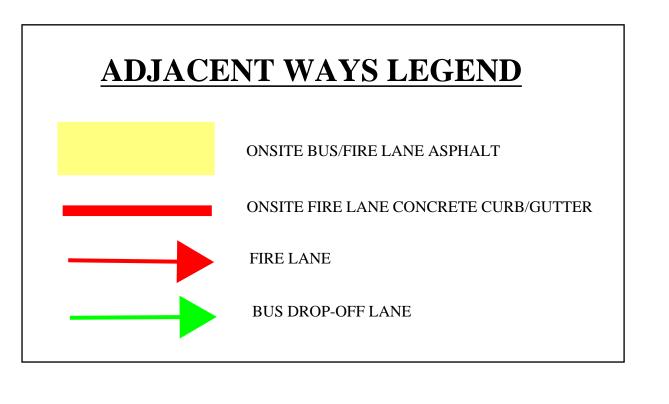




SCALE: 1" = 20'

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Feet

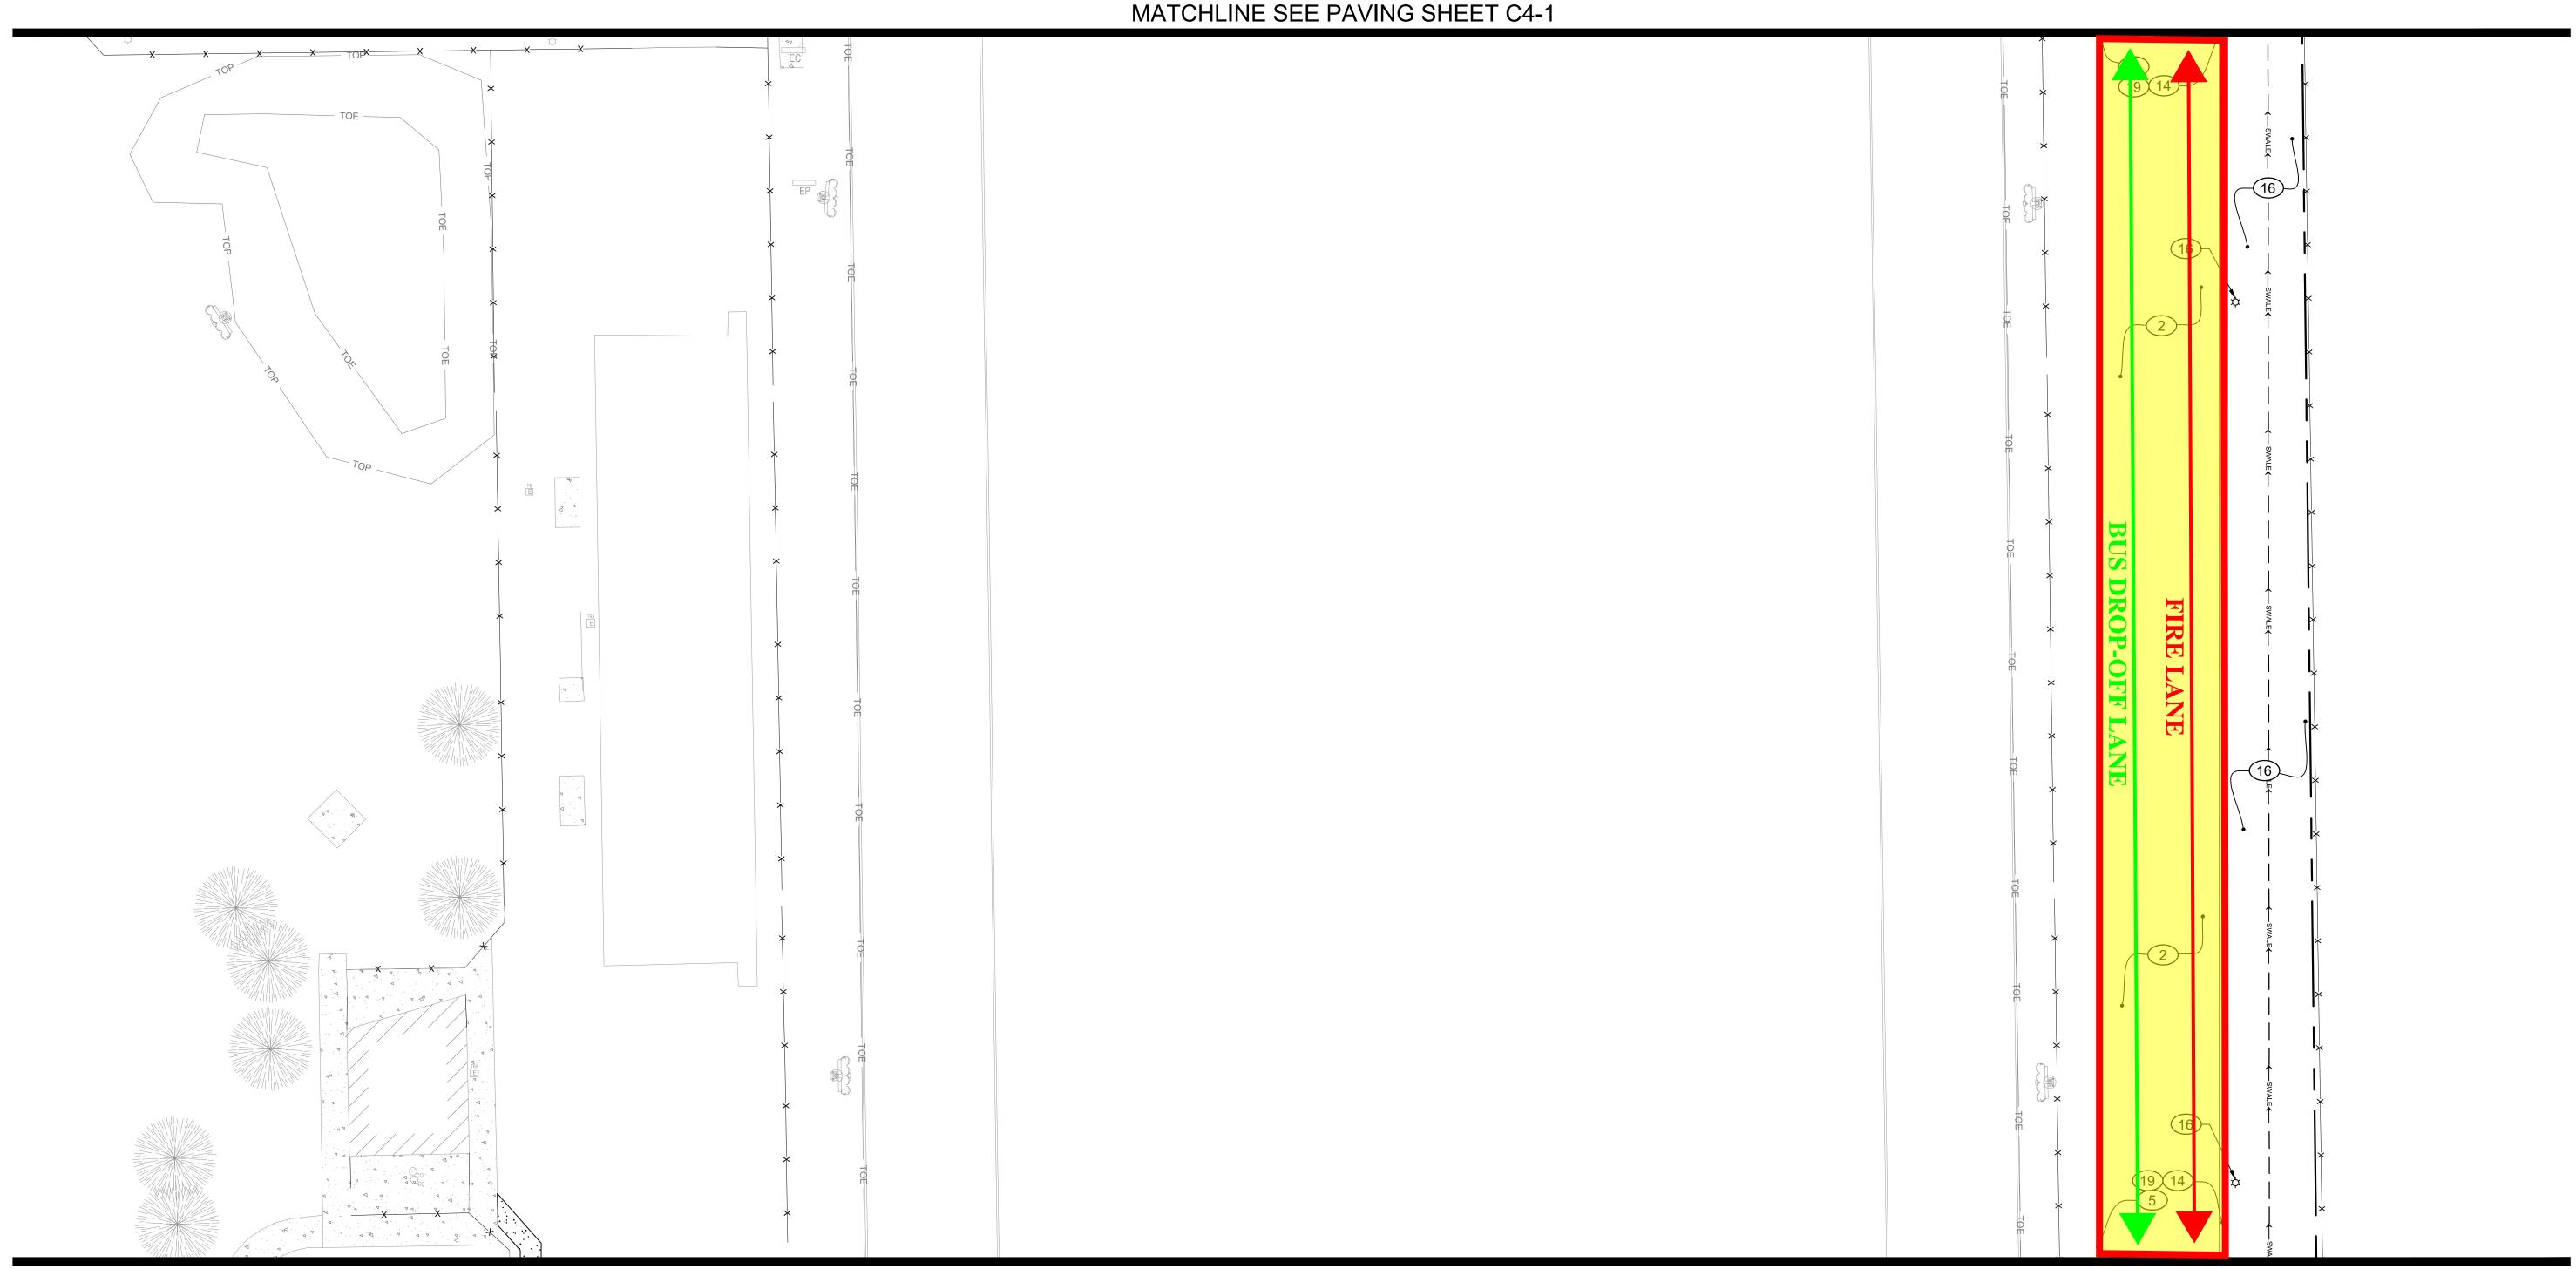

1 CONTRACTOR TO VERIFY ELEVATION OF EXISTING CURB OR SIDEWALK TIE-IN LOCATION AND MATCH EXISTING. NOTIFY ENGINEER

PAVING KEYNOTES:

OF ANY DISCREPANCIES.

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- 8 CONSTRUCT ASPHALT THICKEN EDGE PER MAG STD. DTL. 201 TYPE
- "A".
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- 10 CONSTRUCT 2' RETAINING WALL PER ARCHITECTURAL DETAIL.
- 11) INSTALL CHAIN LINK FENCE AND GATES PER ARCHITECTURAL PLANS.
- REFER TO FUELING PLANS FOR TANK, PUMPS, PIPING, AND SAFETY BOLLARDS.
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- CONSTRUCT 2' RIBBON CURB PER MAG STD. DTL. 220-1 TYPE "B".
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- ANGLE.


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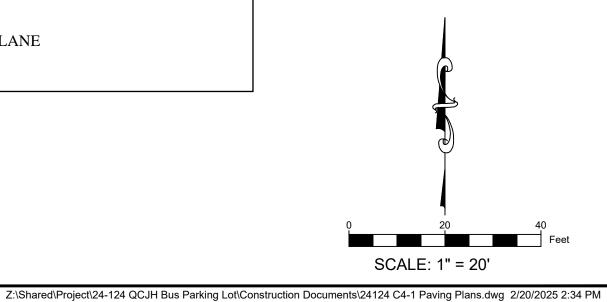
# (3) INCH WHITE LETTERING WITH A $\frac{3}{4}$ INCH STROKE, SPACED AT A MAXIMUM OF FIFTY (50) FEET BETWEEN MARKINGS.

#### NOTES:

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- 2. COORDINATE ALL SLEEVES WITH ELECTRICAL AND LANDSCAPE

# MATCHLINE SEE PAVING SHEET C4-3



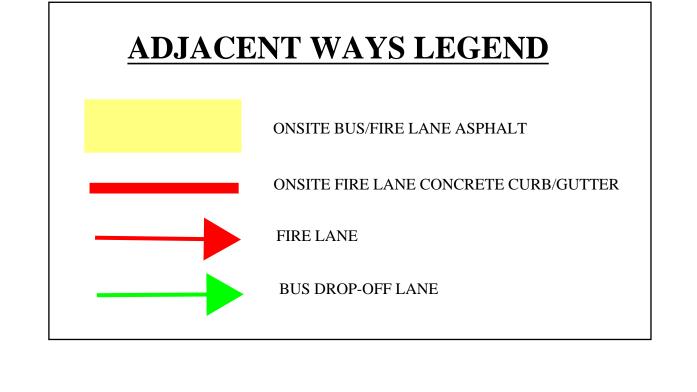



CONSTRUCTION

960 WEST ELLIOT ROAD SUITE 213 TEMPE, ARIZONA 85284 PH 602.635.4226





## QUEEK CREEK JH TRANSPORTATION CENTER ADDITION


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DESIGNED:	JLP
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SCALE:	1" = 20'

PAVING PLAN

DWG. NO

C4-2

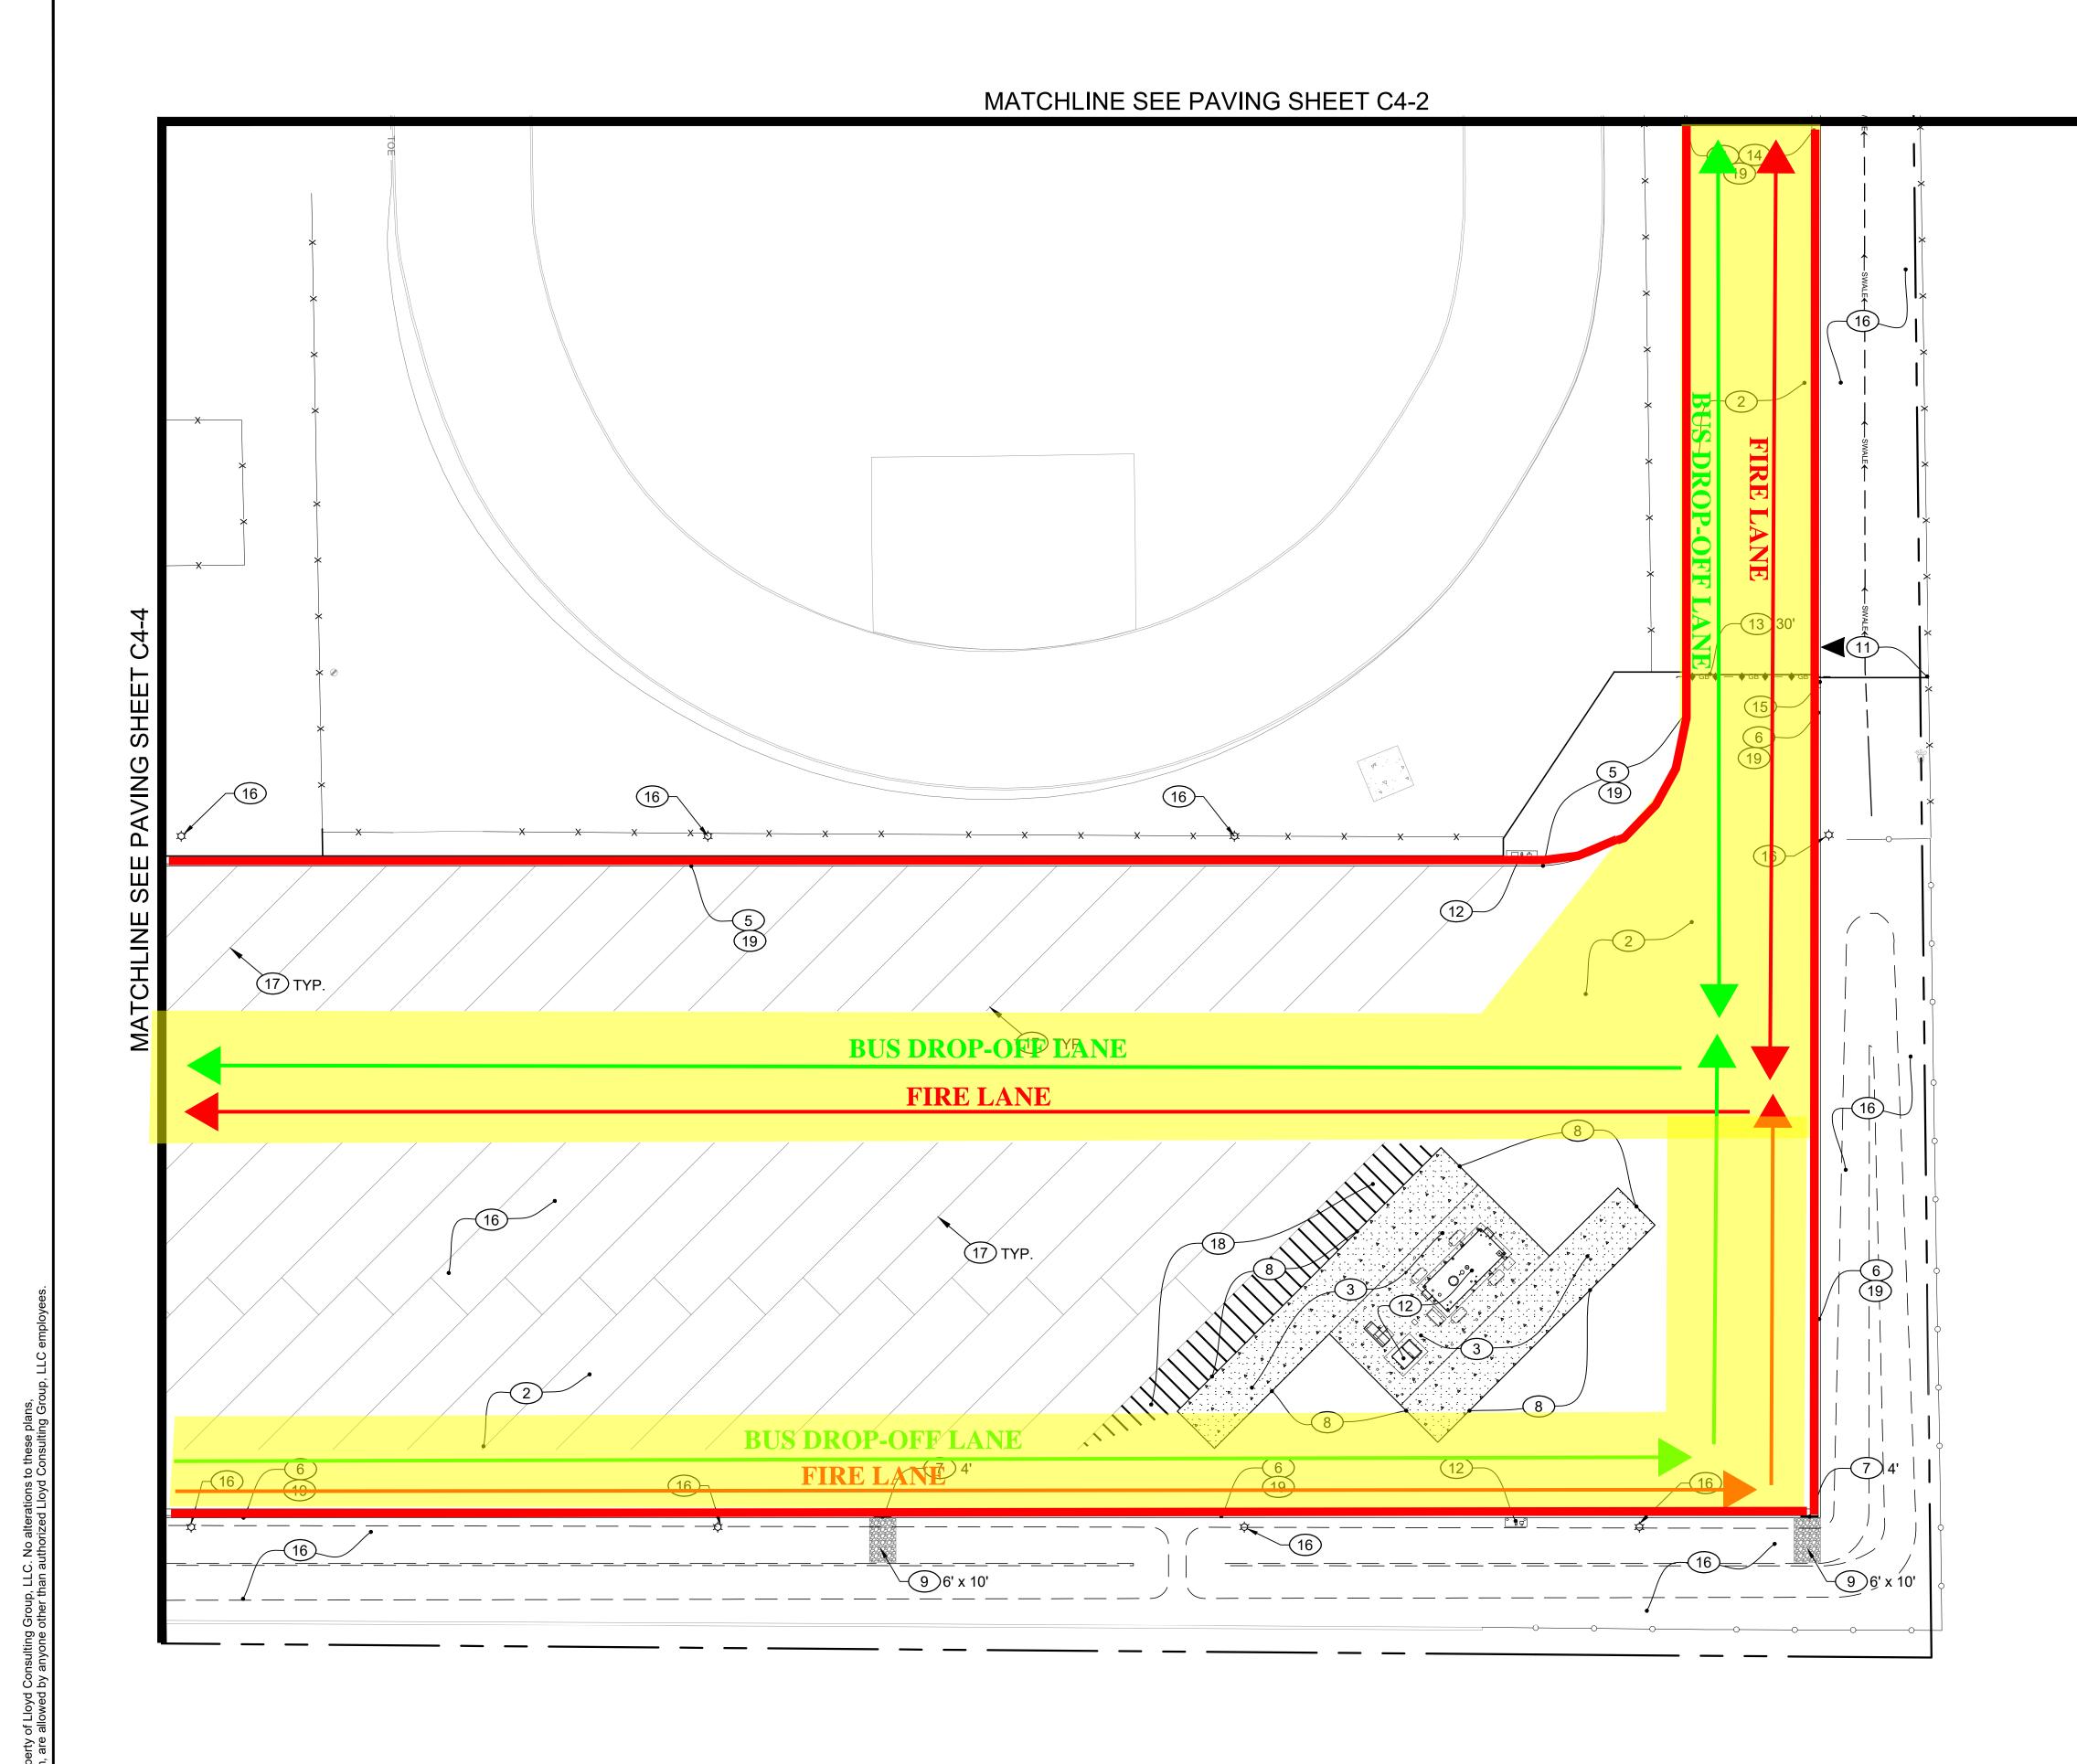


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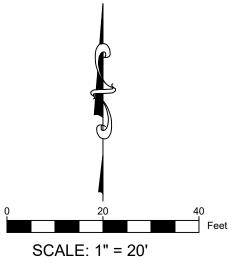
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#### NOTES:

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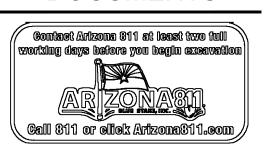
- (11) INSTALL CHAIN LINK FENCE AND GATES PER ARCHITECTURAL PLANS.
- BOLLARDS.

- COORDINATE CONDUIT PRIOR TO CONCRETE OR PAVING.
- 17) INSTALL 4" SOLID WHITE LINE PER PAVEMENT MARKINGS DETAIL 4 ON SHEET C5-1. DIMENSION OF STRIP PER PLAN VIEW.
- NO ACCESS / NO PARKING 4" SOLID WHITE LINE SPACED 3' AT 45°

#### CONSTRUCTION DOCUMENTS

960 WEST ELLIOT ROAD

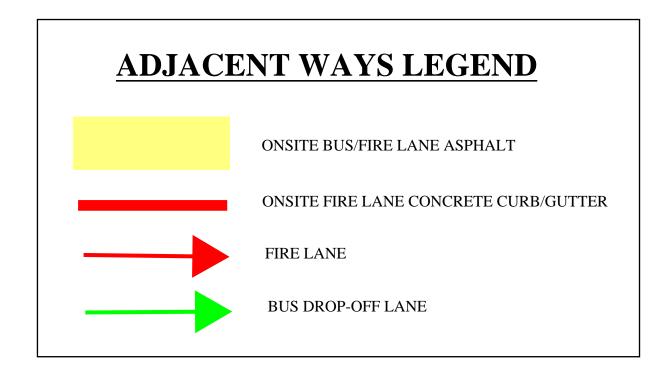SUITE 213 TEMPE, ARIZONA 85284 PH 602.635.4226





### QUEEK CREEK JH **TRANSPORTATION CENTER ADDITION**

20948 E. QUEEN CREEK ROAD QUEEN CREEK, AZ 85142


DESIGNED:	JLP	
DATE:	FEB. 21, 2025	
DRAWN:	JI	
PROJ.	24-124	
SCALE:	1" = 20'	

PAVING PLAN

DWG. NO.

C4-3


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### **ADJACENT WAYS LEGEND**

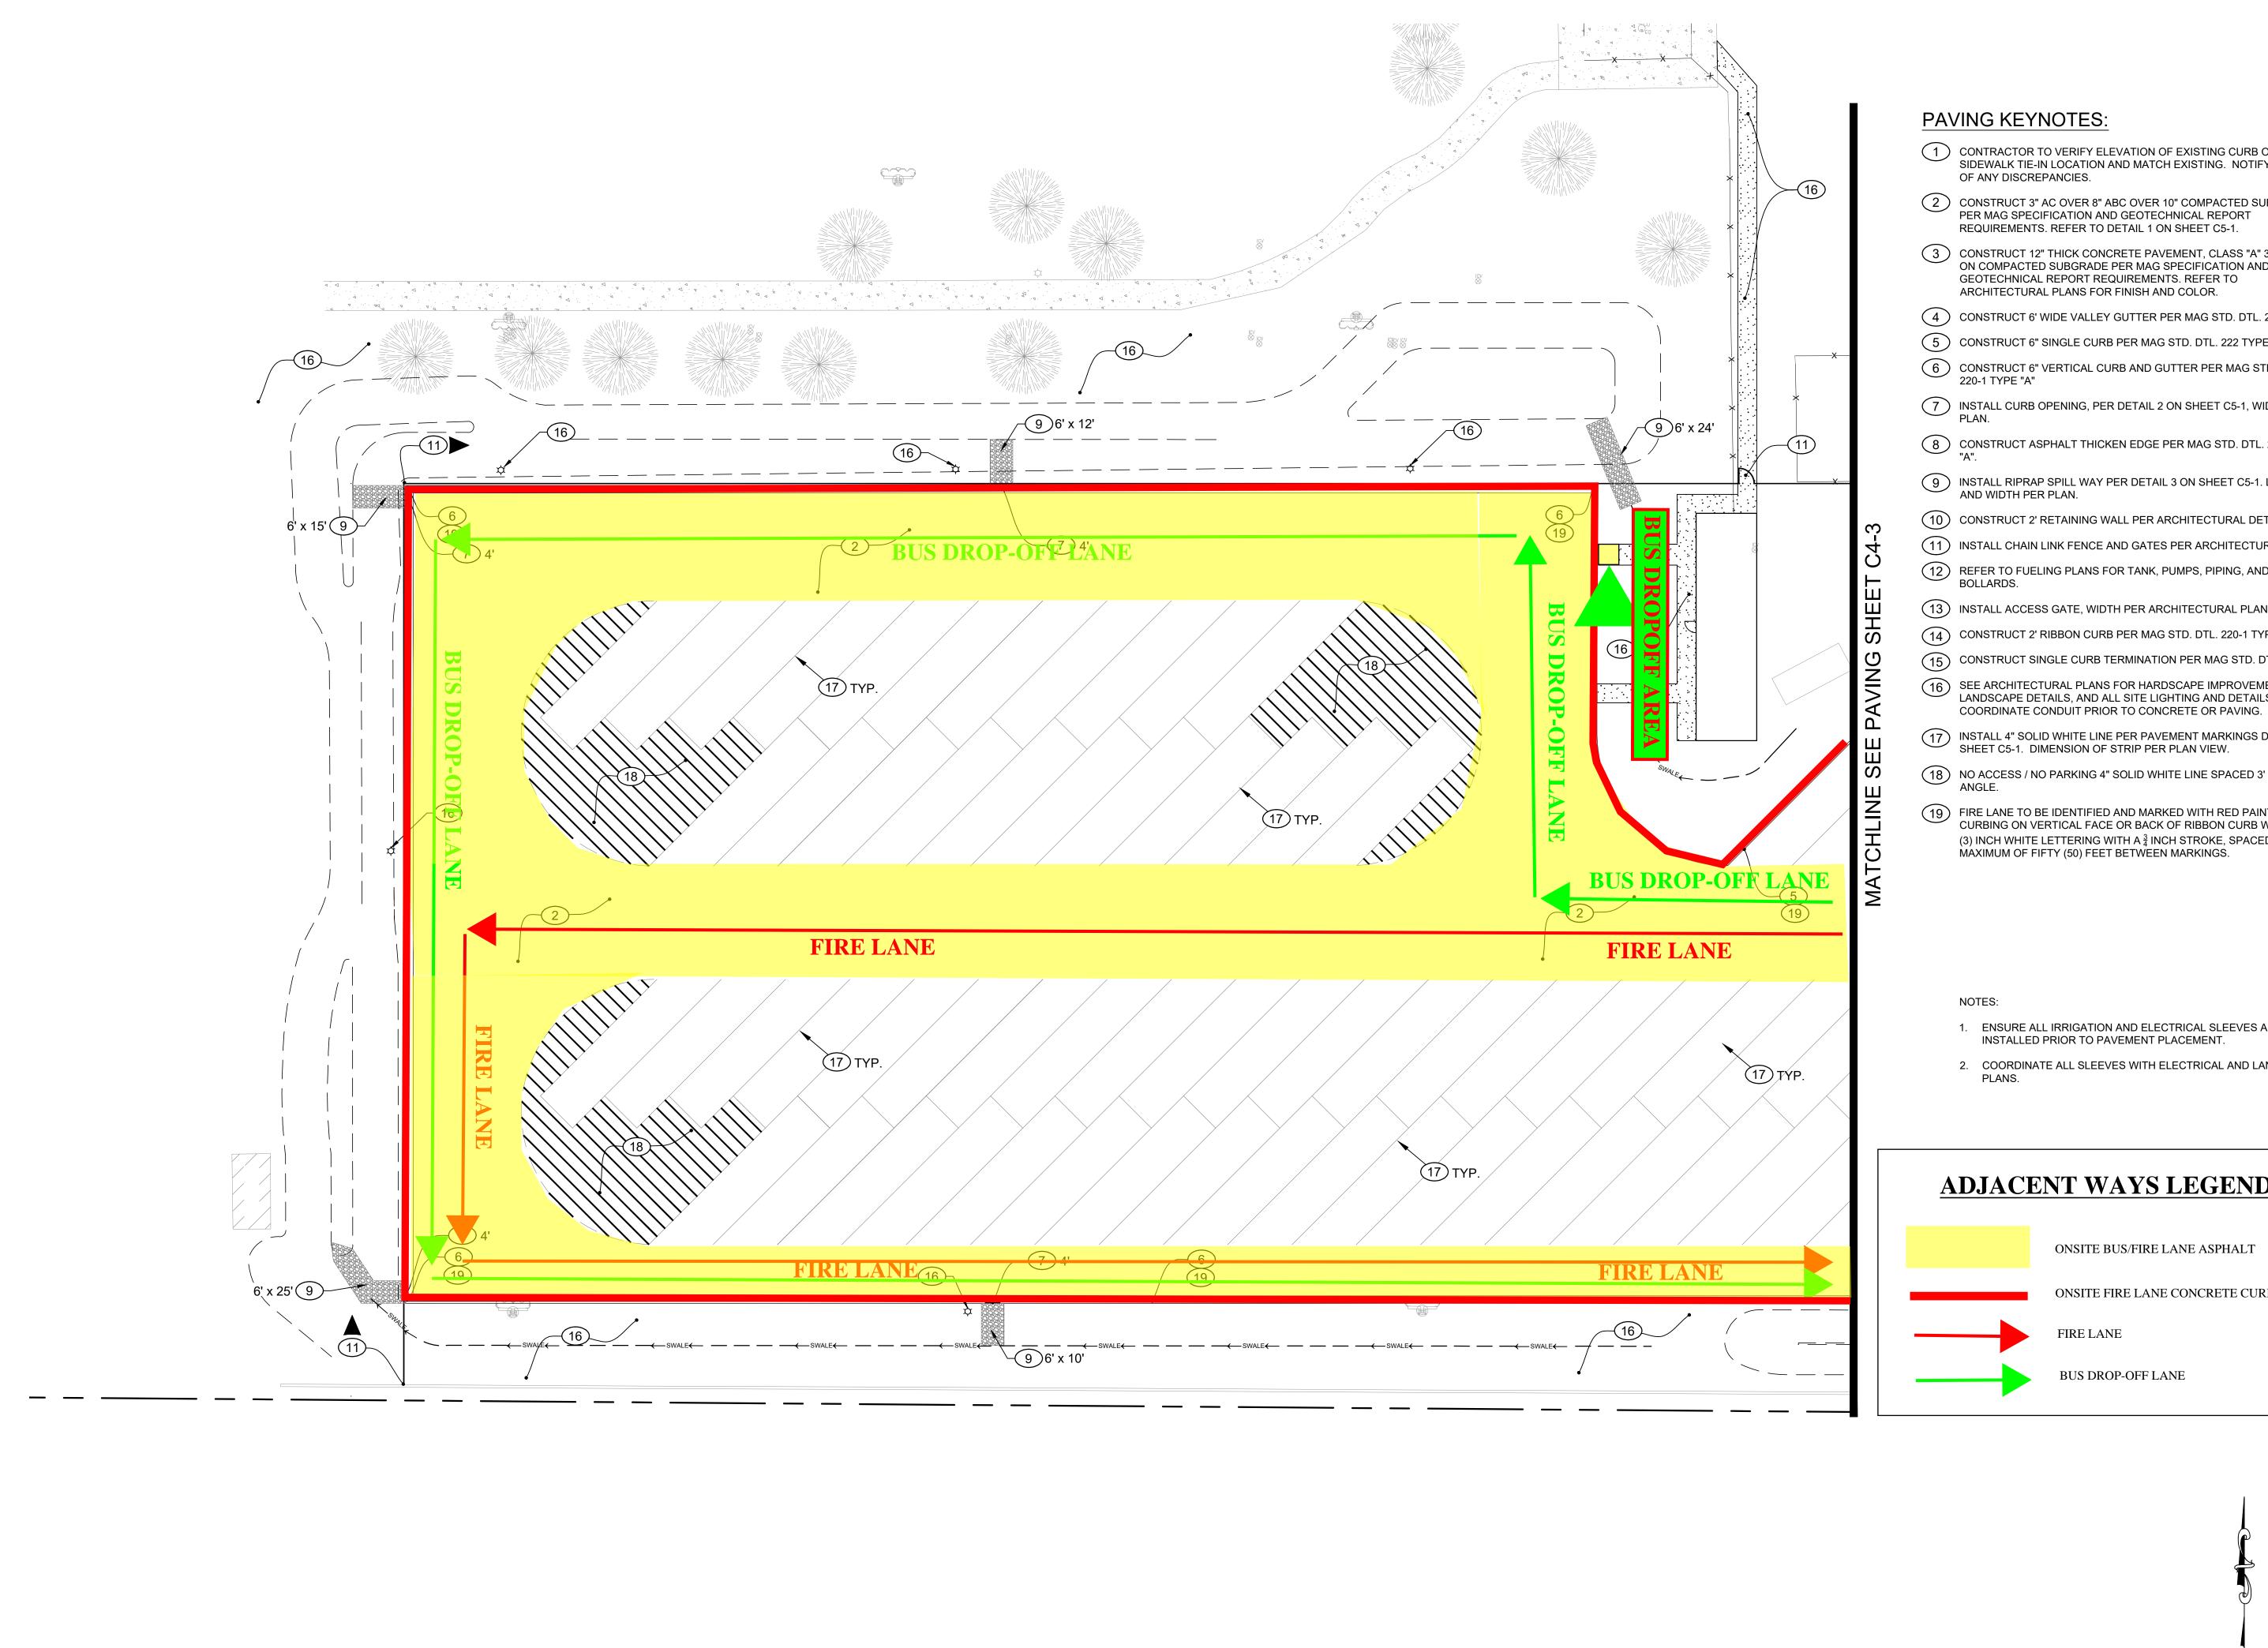

Feet

SCALE: 1" = 20'

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CONSTRUCTION

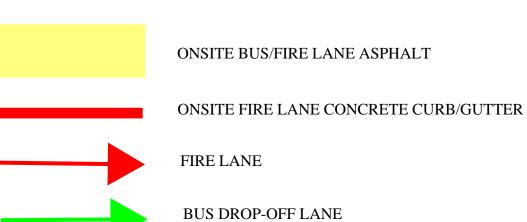DOCUMENTS

Contact Arizona 311 at least two full

Call 811 or eliek Arizona811.com /

960 WEST ELLIOT ROAD

SUITE 213 TEMPE, ARIZONA 85284 PH 602.635.4226

QUEEN CREEK, AZ 85142

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PAVING PLAN

DWG. NO.

C4-4